

# AVON GROVE LIBRARY

## RAIN GARDEN IMPLEMENTATION PROJECT

### 117 ROSEHILL AVENUE, WEST GROVE BOROUGH CHESTER COUNTY, PENNSYLVANIA

PA UPI: 5-4-198.1-E

**PROJECT DESCRIPTION:**

A RAIN GARDEN (845 S.F.) IS TO BE IMPLEMENTED ON THE LAWN IN FRONT OF THE WEST ENTRANCE OF THE LIBRARY TO CAPTURE, TREAT, AND INFILTRATE STORMWATER RUNOFF FROM THE ROOF (4,215 S.F.).

**LOCATION MAP:**



**LIST OF DRAWINGS:**

SHEET NAME	TITLE
COVER	COVER SHEET
P-1	EXISTING CONDITIONS AND DEMOLITION PLAN
P-2	PROPOSED SITE PLAN
P-3	PLANTING PLAN
DT-1	RAIN GARDEN DETAILS
DT-2	RENDERING

**GENERAL NOTES:**

- ELEVATION DATA OBTAINED FROM NOAA DIGITAL COASTAL LIDAR. ELEVATIONS ARE HEIGHT ABOVE MEAN SEA LEVEL SET BY NAVD 1988.
- EXISTING SOILS ARE CHANNERY SILT LOAM WHICH ARE CLASSIFIED AS HYDROLOGIC SOIL GROUP B WHICH HAVE MODERATE INFILTRATION RATES BASED ON THE NRCS WEB SOIL SURVEY ([websoilsurvey.sc.egov.usda.gov](http://websoilsurvey.sc.egov.usda.gov)).
- ANY OVERHEAD AND UNDERGROUND UTILITIES SHOWN ARE FROM FIELD OBSERVATIONS AND ARE NOT A COMPLETE REPRESENTATION. A UTILITY MARKOUT NEEDS TO BE CONDUCTED PRIOR TO MOBILIZATION.

**LEGEND:**

-----	EXISTING DRAINAGE AREA
———	EDGE OF PAVEMENT
←-----	EXISTING CENTERLINE
-----	EXISTING FENCE
~~~~~	EXISTING TREELINE
○	EXISTING TREE/SHRUB
▨	EXISTING BUILDING
—●—	EXISTING UTILITY POLE
▩	EXISTING CATCH BASIN
⤵	EXISTING CONTOURS
-----	LIMIT OF WORK
▨	PROPOSED GREEN INFRASTRUCTURE
———	PROPOSED TOP OF BERM

CHRISTOPHER C. OBROPTA, Ph.D., P.E.  
PROFESSIONAL ENGINEER - NJ LICENSE # 37532  
*Christopher C. Obropta*  
DATE 03/03/20  
APPROVED CCO  
CHECKED MAL  
DRAWN RPK

REVISIONS	No.	DATE	DESCRIPTION

AVON GROVE LIBRARY  
RAIN GARDEN IMPLEMENTATION PROJECT  
117 ROSEHILL AVENUE, WEST GROVE BOROUGH  
CHESTER COUNTY, PA  
**COVER SHEET**



SHEET NAME  
COVER

**DRAFT**



# RAILROAD AVENUE

- PLAN NOTES:**
1. CONTRACTOR SHALL SCHEDULE MEETING WITH ENGINEER AND PROPERTY OWNER PRIOR TO MOBILIZATION.
  2. CONTRACTOR SHALL VERIFY ALL INFORMATION INCLUDING ELEVATIONS AND UTILITIES PRIOR TO MOBILIZATION.
  3. CONTRACTOR SHALL BE RESPONSIBLE FOR OBTAINING REQUIRED APPROVALS FROM AUTHORITIES WITH JURISDICTION OVER PROPOSED WORK.
  4. CONTRACTOR SHALL COORDINATE AND CONFIRM PROJECT SCHEDULE AND WORKING HOURS WITH ENGINEER AND PROPERTY OWNER AND PROCEED IN ACCORDANCE WITH LOCAL REQUIREMENTS.
  5. CONTRACTOR SHALL COORDINATE UTILITY MARK OUT PRIOR TO MOBILIZATION. NJ ONE CALL: 811 OR 800-272-1000
  6. CONTRACTOR SHALL CONDUCT PERMEABILITY TESTING TO VERIFY ADEQUATE INFILTRATION RATES IF NOT PREVIOUSLY PERFORMED.
  7. CONTRACTOR SHALL HAUL REMOVED DEBRIS OFF SITE UNLESS OTHERWISE NOTED BY PROPERTY OWNER.

CHRISTOPHER C. OBROPTA, Ph.D., P.E.  
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EXISTING CONDITIONS AND DEMOLITION PLAN



SHEET NAME  
P-1

EXISTING RAILROAD

DRAINAGE AREA  
(4,215 S.F.)

EXISTING ELECTRICAL BOX

LIMIT OF WORK  
(4,750 S.F.)

EXISTING FLAG POLE

EXISTING LANDSCAPED AREA  
(TO BE REMOVED)

EXISTING LIGHT POLE

EXISTING LANDSCAPED AREA


EXISTING CONNECTED DOWNSPOUT

EXISTING LANDSCAPED AREA

AVON GROVE LIBRARY

EXISTING CONNECTED DOWNSPOUT

EXISTING SIGN

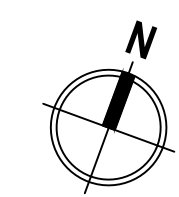

0 10' 20'  
SCALE 1" = 10'-0"

**DRAFT**

EXISTING PLAN




- PLAN NOTES:**
1. CONTRACTOR SHALL SCHEDULE MEETING WITH ENGINEER AND PROPERTY OWNER PRIOR TO MOBILIZATION AND CONSTRUCTION.
  2. CONTRACTOR SHALL VERIFY ALL INFORMATION INCLUDING ELEVATIONS AND UTILITIES PRIOR TO CONSTRUCTION.
  3. CONTRACTOR SHALL VERIFY ALL PROPOSED MATERIALS WITH PROPERTY OWNER AND ENGINEER PRIOR TO CONSTRUCTION.
  4. CONTRACTOR SHALL STAKE OUT LOCATIONS OF PROPOSED BMPs AND OBTAIN APPROVAL FROM ENGINEER PRIOR TO INSTALLATION.
  5. CONTRACTOR SHALL GRADE SITE AS SHOWN ON PLAN. CUT SOIL SHALL BE REUSED ON SITE FOR FILL LOCATIONS.
  6. CONTRACTOR SHALL HAUL EXCESS SOIL OFF SITE UNLESS OTHERWISE NOTED BY PROPERTY OWNER.
  7. ALL FINISHED ELEVATIONS SHALL MATCH ADJOINING PAVEMENT ENSURING SMOOTH TRANSITIONS AND NO TRIPPING HAZARDS
  8. CONTRACTOR SHALL BE RESPONSIBLE FOR RESTORING ALL AREAS DISTURBED DURING CONSTRUCTION TO ORIGINAL CONDITIONS.

**NOTE 1:** STONE SHALL BE COMPRISED OF 3"-5" DIAMETER CLEAN, WASHED RIVER STONE. ALL AREAS OF EROSION PROTECTION STONE SHALL BE UNDERLAIN WITH GEOTEXTILE FABRIC (GEOTEX 801 BY PROPEX OR APPROVED EQUIVALENT).


**NOTE 2:** UNDERDRAIN MAY BE OMITTED BY ENGINEER'S DISCRETION IF THE TESTED INFILTRATION RATE EXCEEDS 1 IN/HR PER NJDEP BMP MANUAL.

STORMWATER CALCULATIONS								
GREEN INFRASTRUCTURE PRACTICE	SIZE (SF)	STORAGE VOLUME (CF)	TOTAL DRAINAGE AREA (SF)	STORM TYPE	MANAGED DRAINAGE AREA (SF)	PEAK RUNOFF REDUCTION (CFS)	RUNOFF VOLUME MANAGED (GAL)	ANNUAL RUNOFF VOLUME MANAGED (GAL/YR)
RAIN GARDEN	845	650	4,215	2-YR	4,125	0.24	7,974	68,536

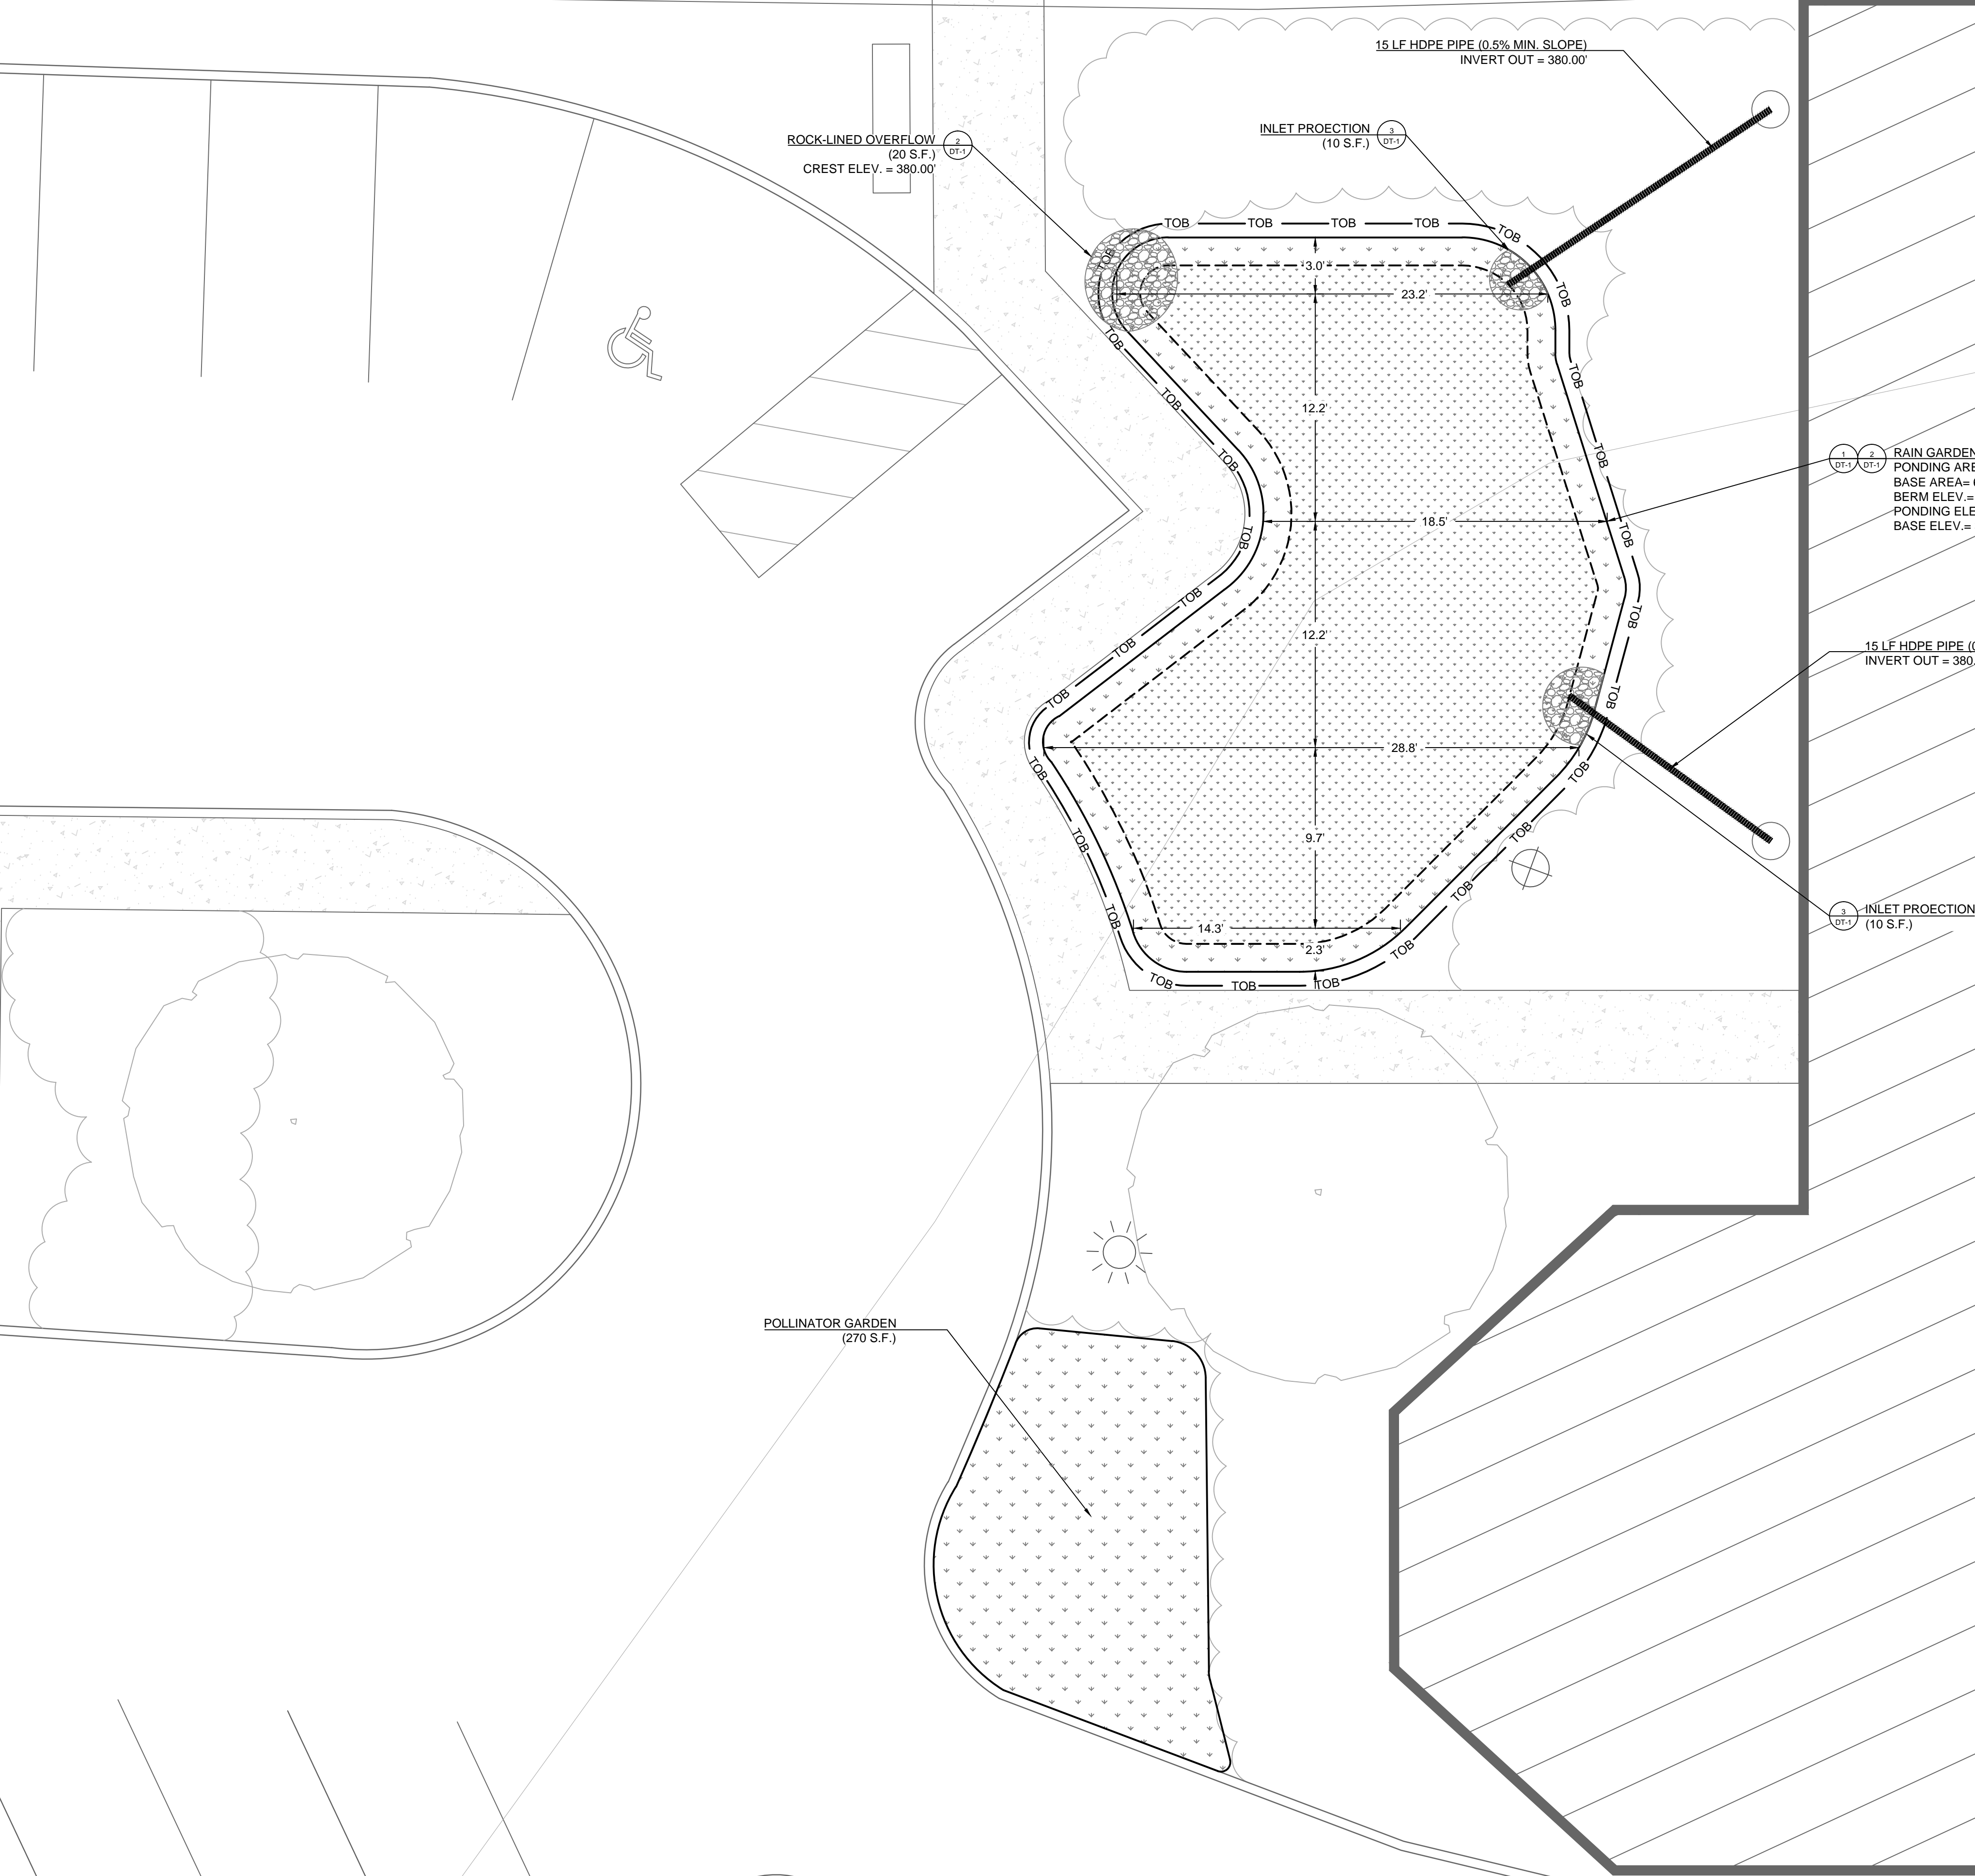

# AVON GROVE LIBRARY

**DRAFT**

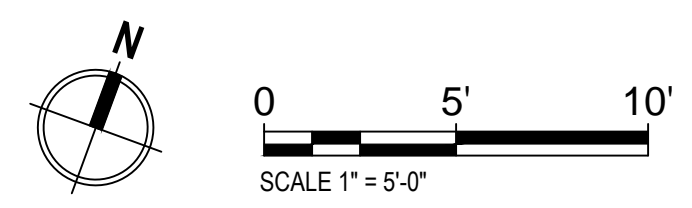

**SITE PLAN**

CHRISTOPHER C. OBROPTA, Ph.D., P.E.  
 PROFESSIONAL ENGINEER - NJ LICENSE # 37552  
 DATE 03/03/20  
 APPROVED CCO  
 CHECKED MAL  
 DRAWN RPK

REVISIONS		DESCRIPTION
No.	DATE	


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**PROPOSED SITE PLAN**




SHEET NAME  
**P-2**



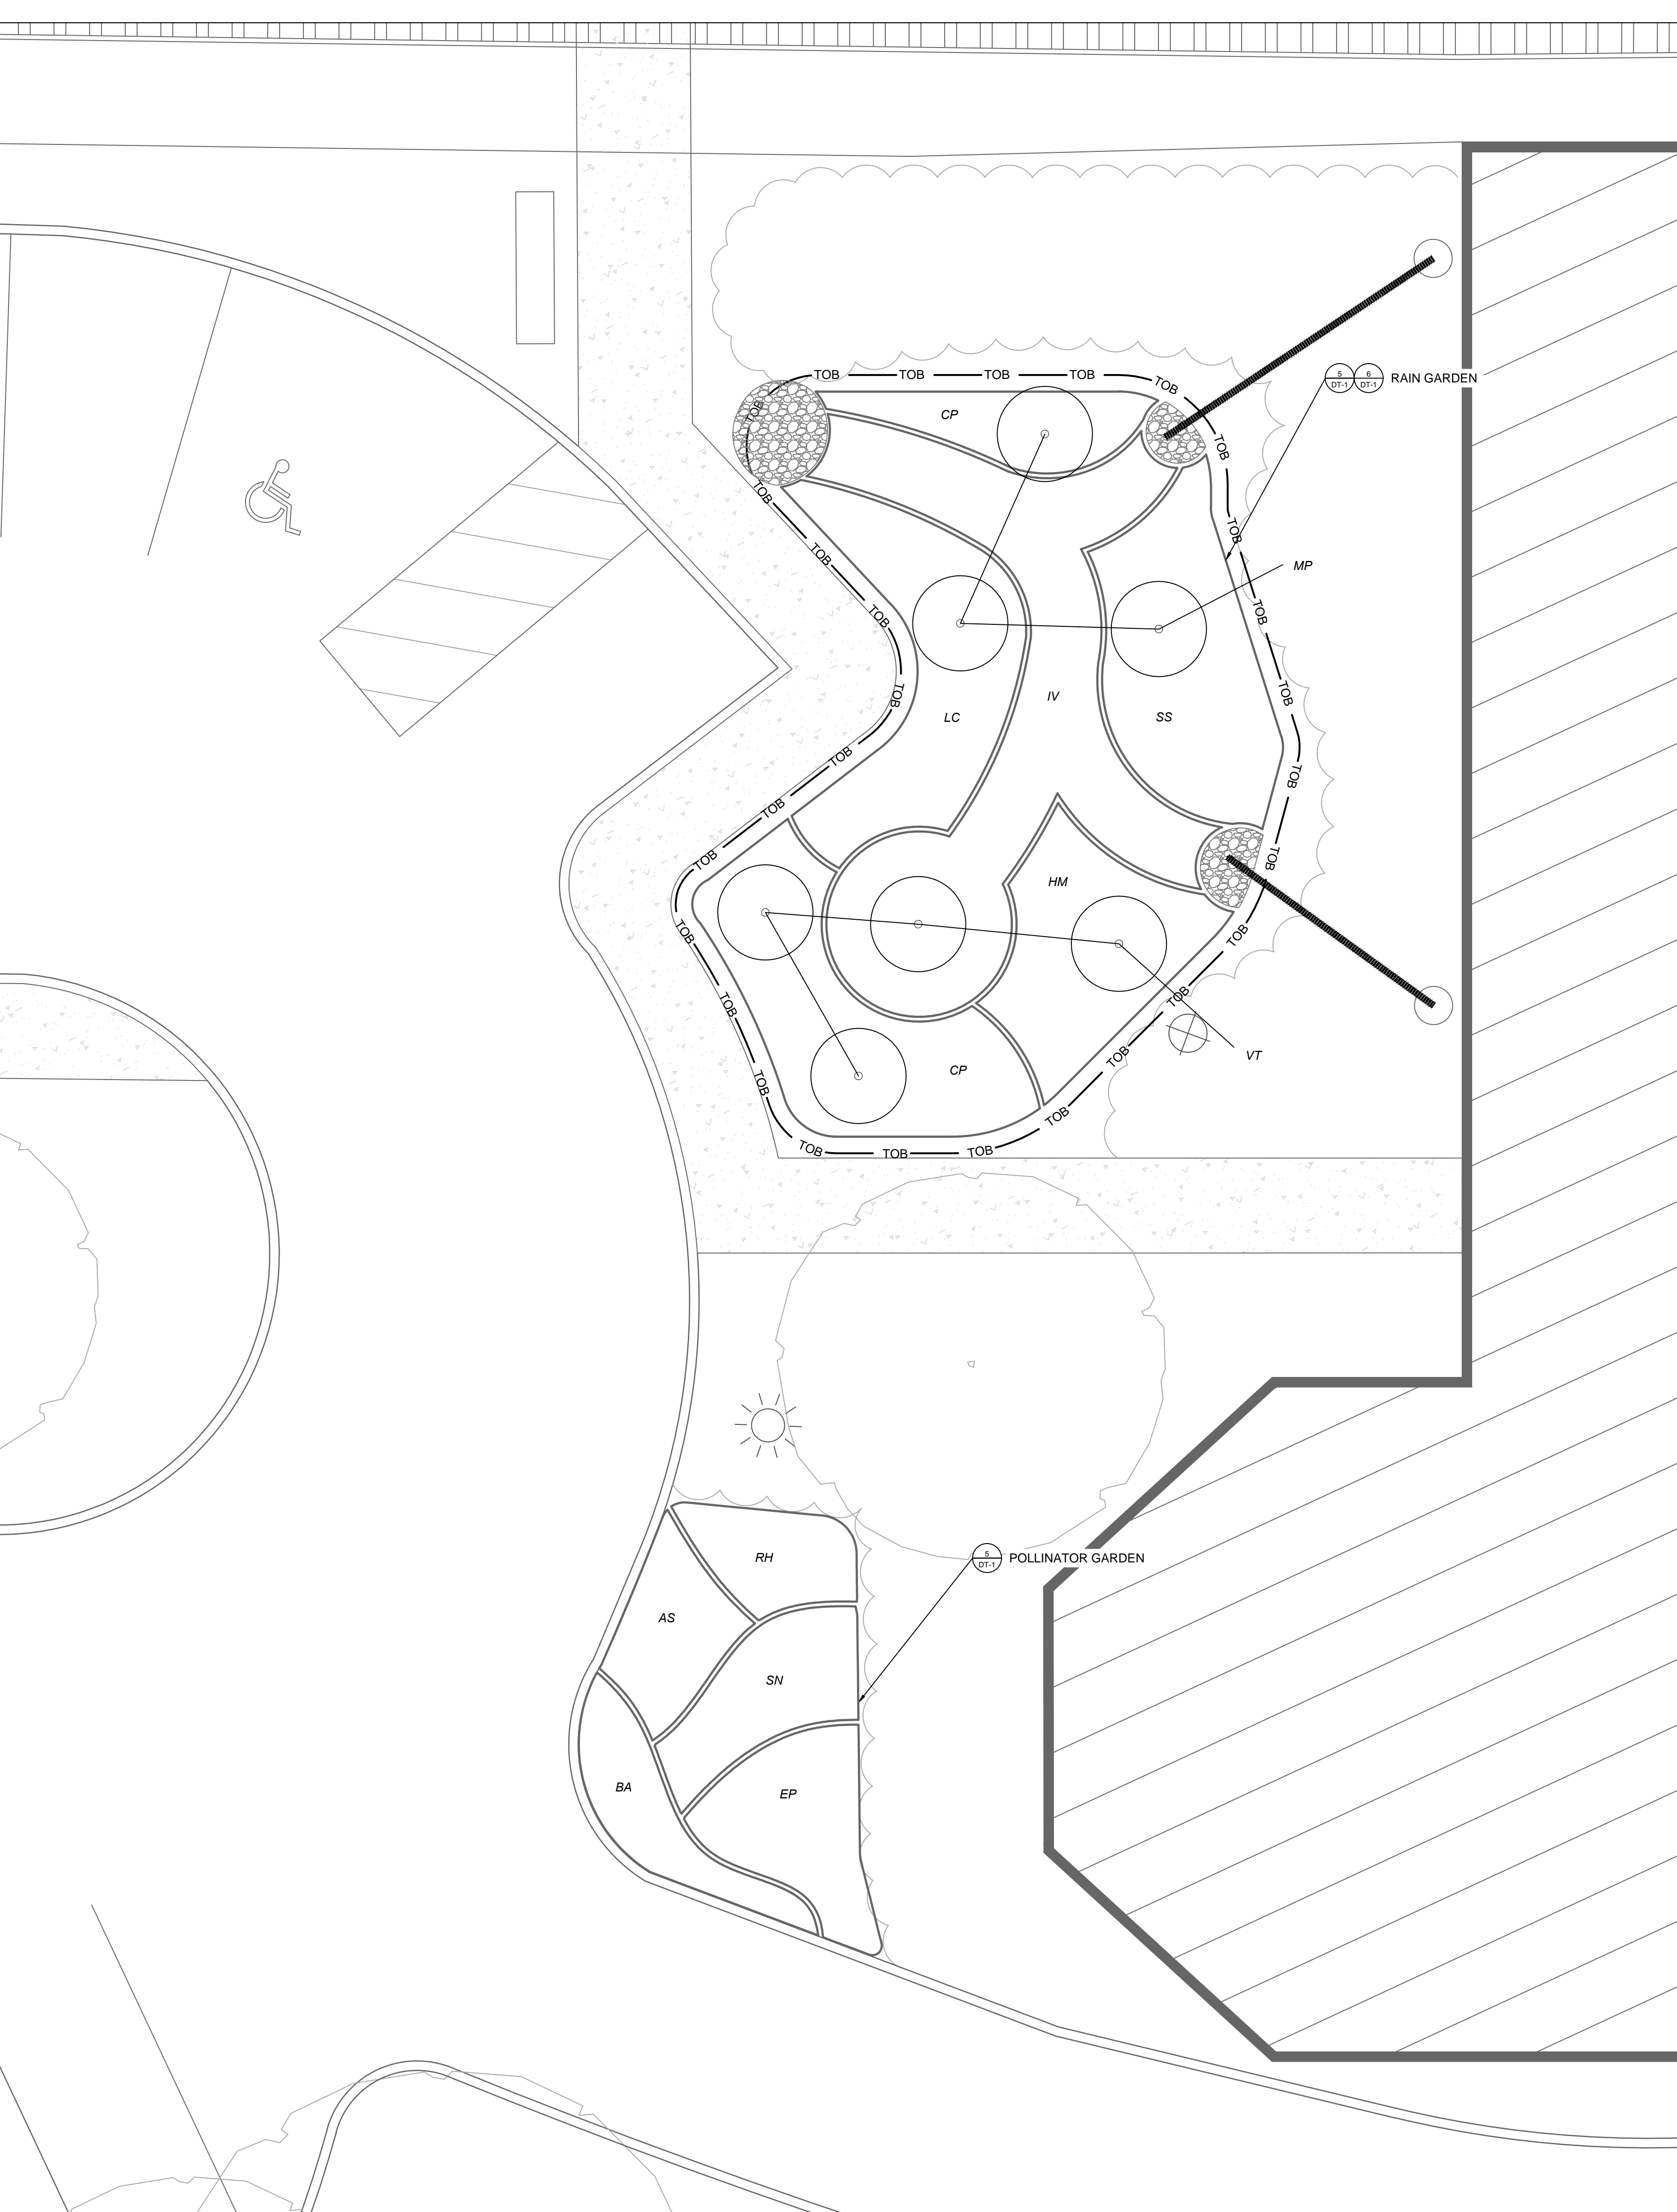

PLANTING SCHEDULE					
PLANT SPECIES				QUANTITY	SIZE
TYPE	KEY	BOTANICAL NAME	COMMON NAME		
RAIN GARDEN					
PERRINALS	CP	<i>Calthus palustris</i>	MARSH MARIGOLD	60	1 QUART
	HM	<i>Hibiscus moscheutos</i>	ROSE-MALLOW	30	1 QUART
	IV	<i>Iris versicolor</i>	BLUE FLAG IRIS	80	1 QUART
	LC	<i>Lobelia cardinalis</i>	CARDINAL FLOWER	40	1 QUART
	SS	<i>Schizachyrium scoparium</i>	LITTLE BLUESTEM	40	1 QUART
SHRUBS	MP	<i>Myrica pensylvanica</i>	BAYBERRY	3	#2 CONT.
	VT	<i>Viburnum trilobum</i>	CRANBERRYBUSH	4	#2 CONT.
POLLINATOR GARDEN					
PERRINALS	AS	<i>Asclepias syriaca</i>	COMMON MILKWEED	15	1 QUART
	BA	<i>Baptisia australis</i>	BLUE WILD INDIGO	15	1 QUART
	EP	<i>Eutrochium purpureum</i>	JOE PYE WEED	20	1 QUART
	RH	<i>Rudbeckia Hirta</i>	BLACK-EYED SUSAN	15	1 QUART
	SN	<i>Symphotrichum novae-angliae</i>	NEW ENGLAND ASTER	20	1 QUART

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PLANTING PLAN
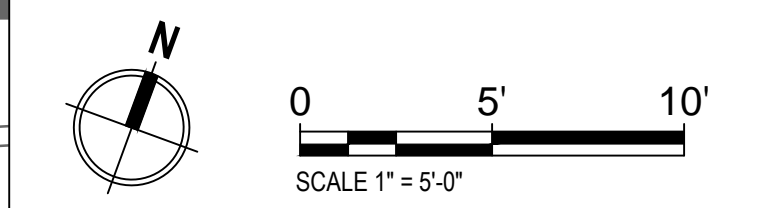
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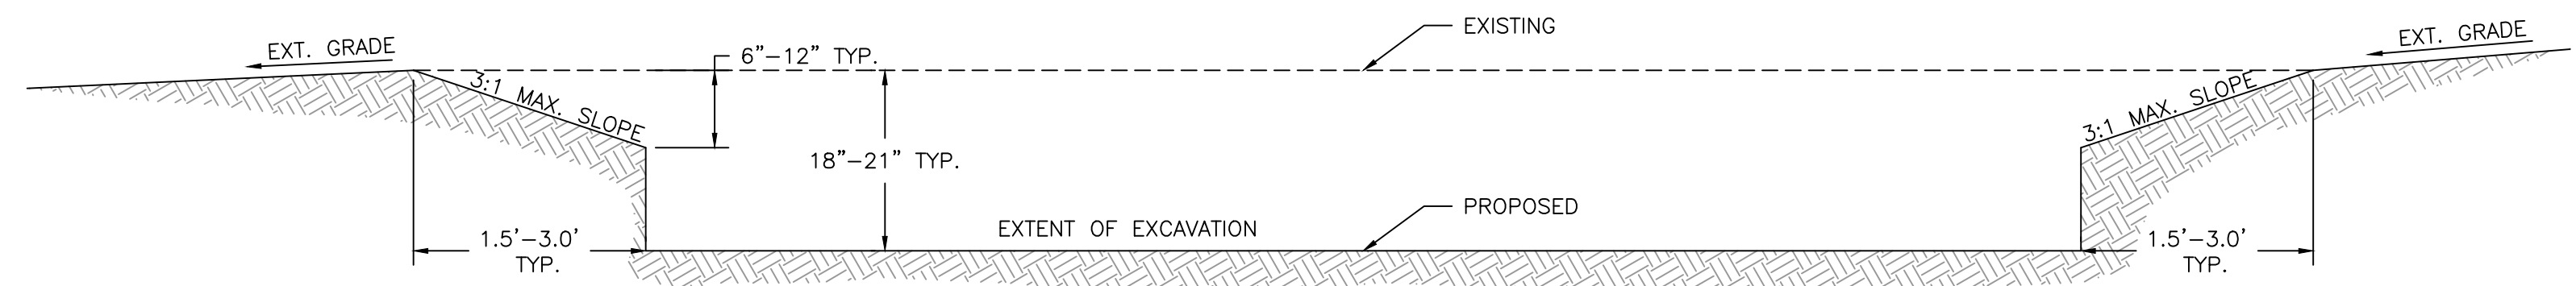
CHECKED: MAL  
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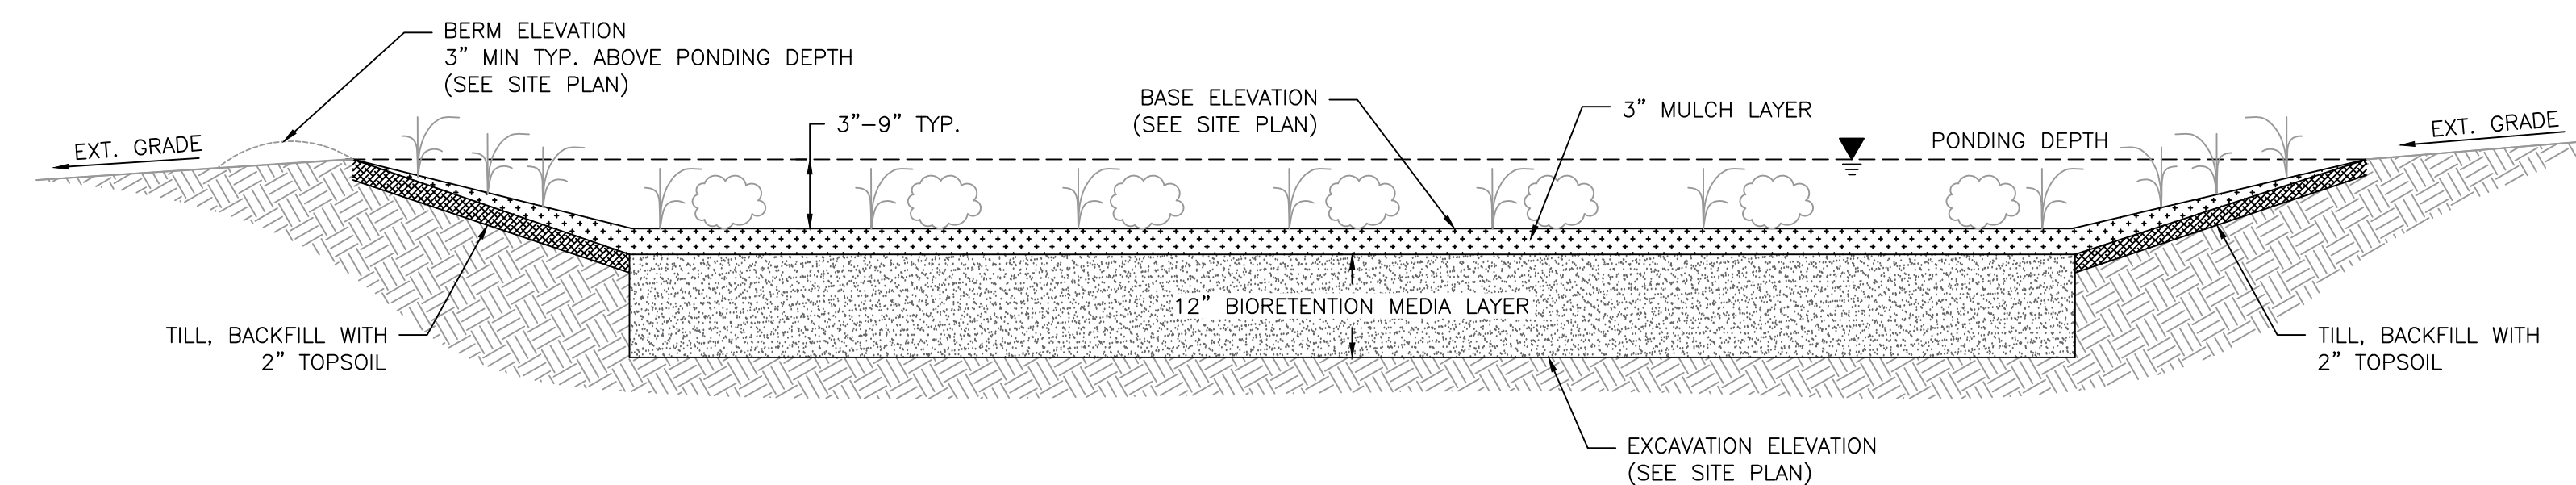
**RUTGERS**  
New Jersey Agricultural  
Experiment Station

SHEET NAME  
P-3







1 RAIN GARDEN EXCAVATION SECTION  
DT-1 N.T.S.




2 RAIN GARDEN CROSS-SECTION  
DT-1 N.T.S.

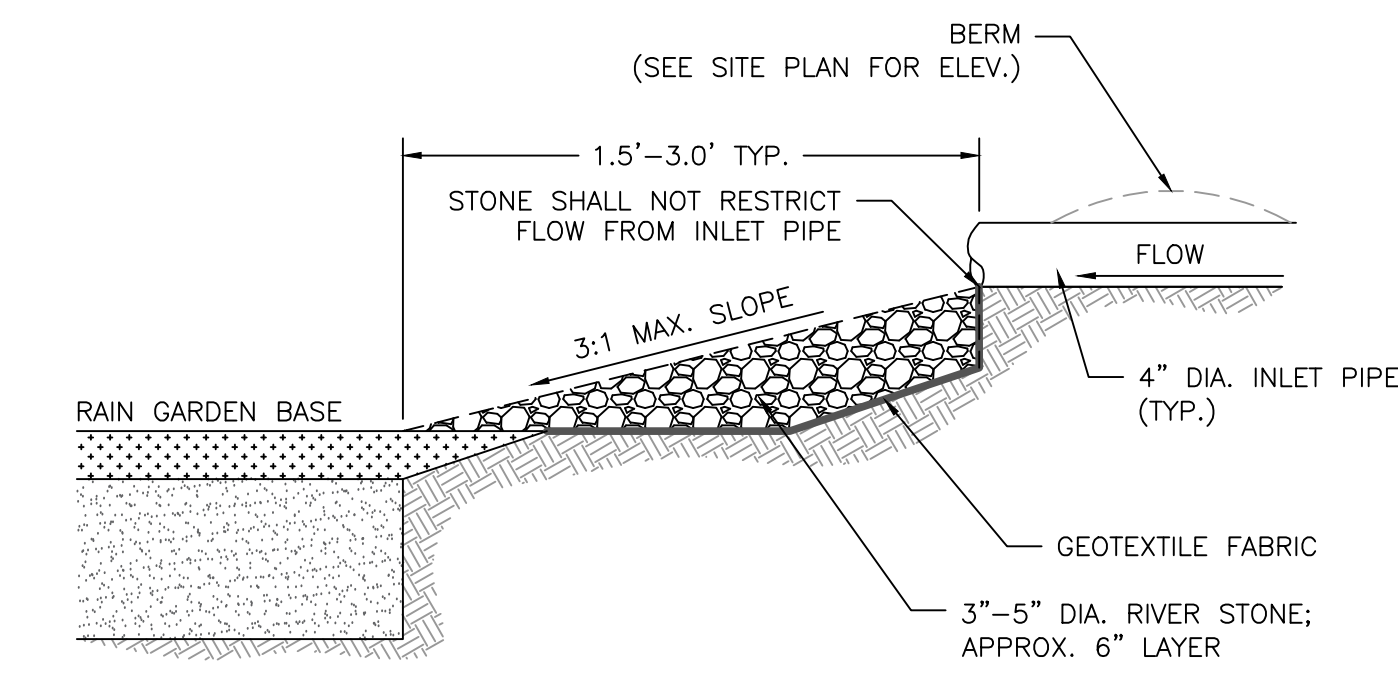


3 INLET PROTECTION CROSS-SECTION  
DT-1 N.T.S.

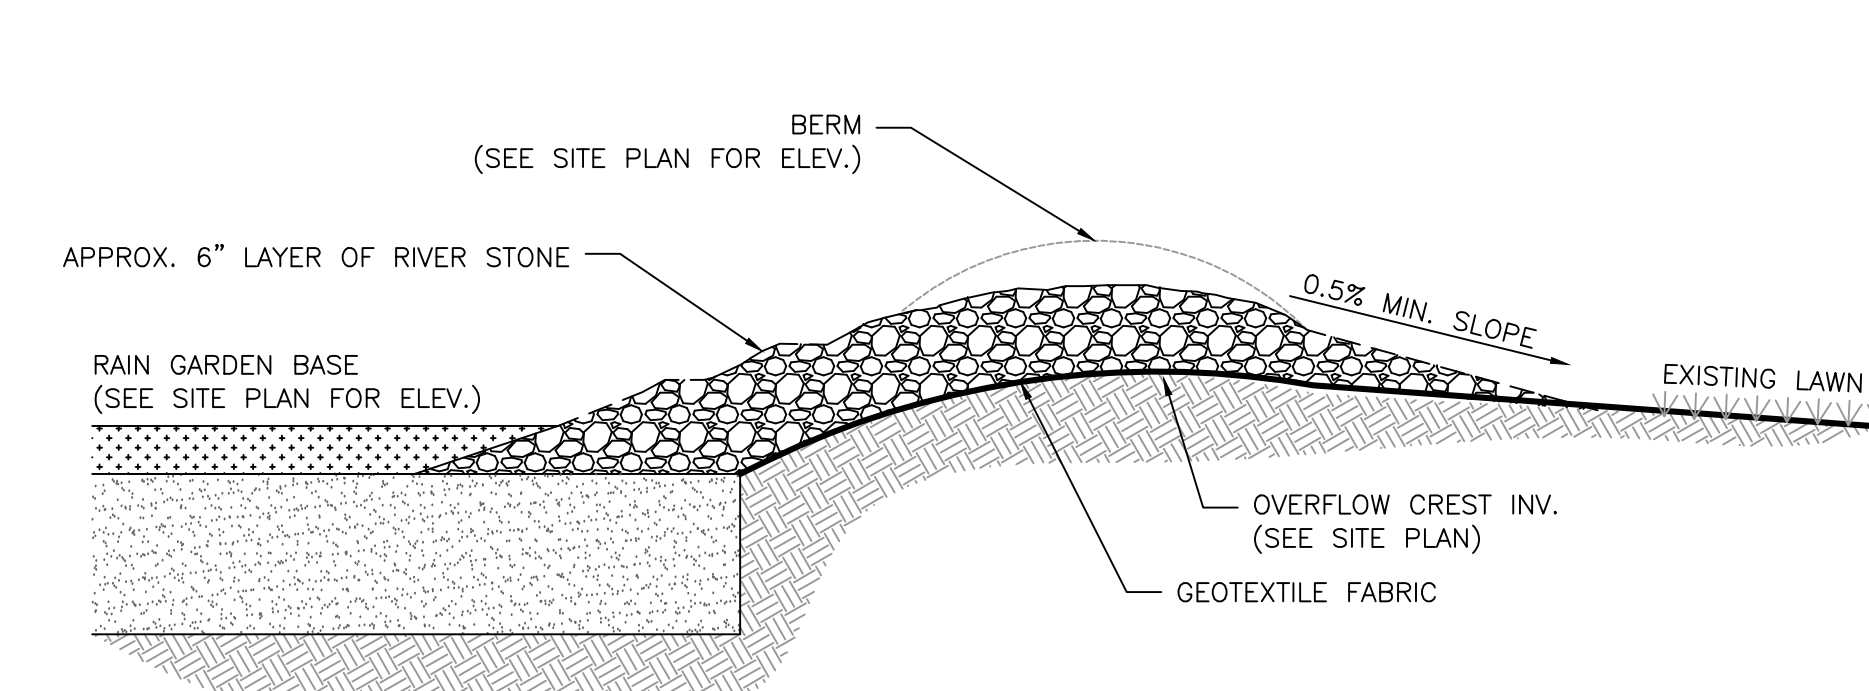

4 ROCK-LINED OVERFLOW DETAIL  
DT-1 N.T.S.

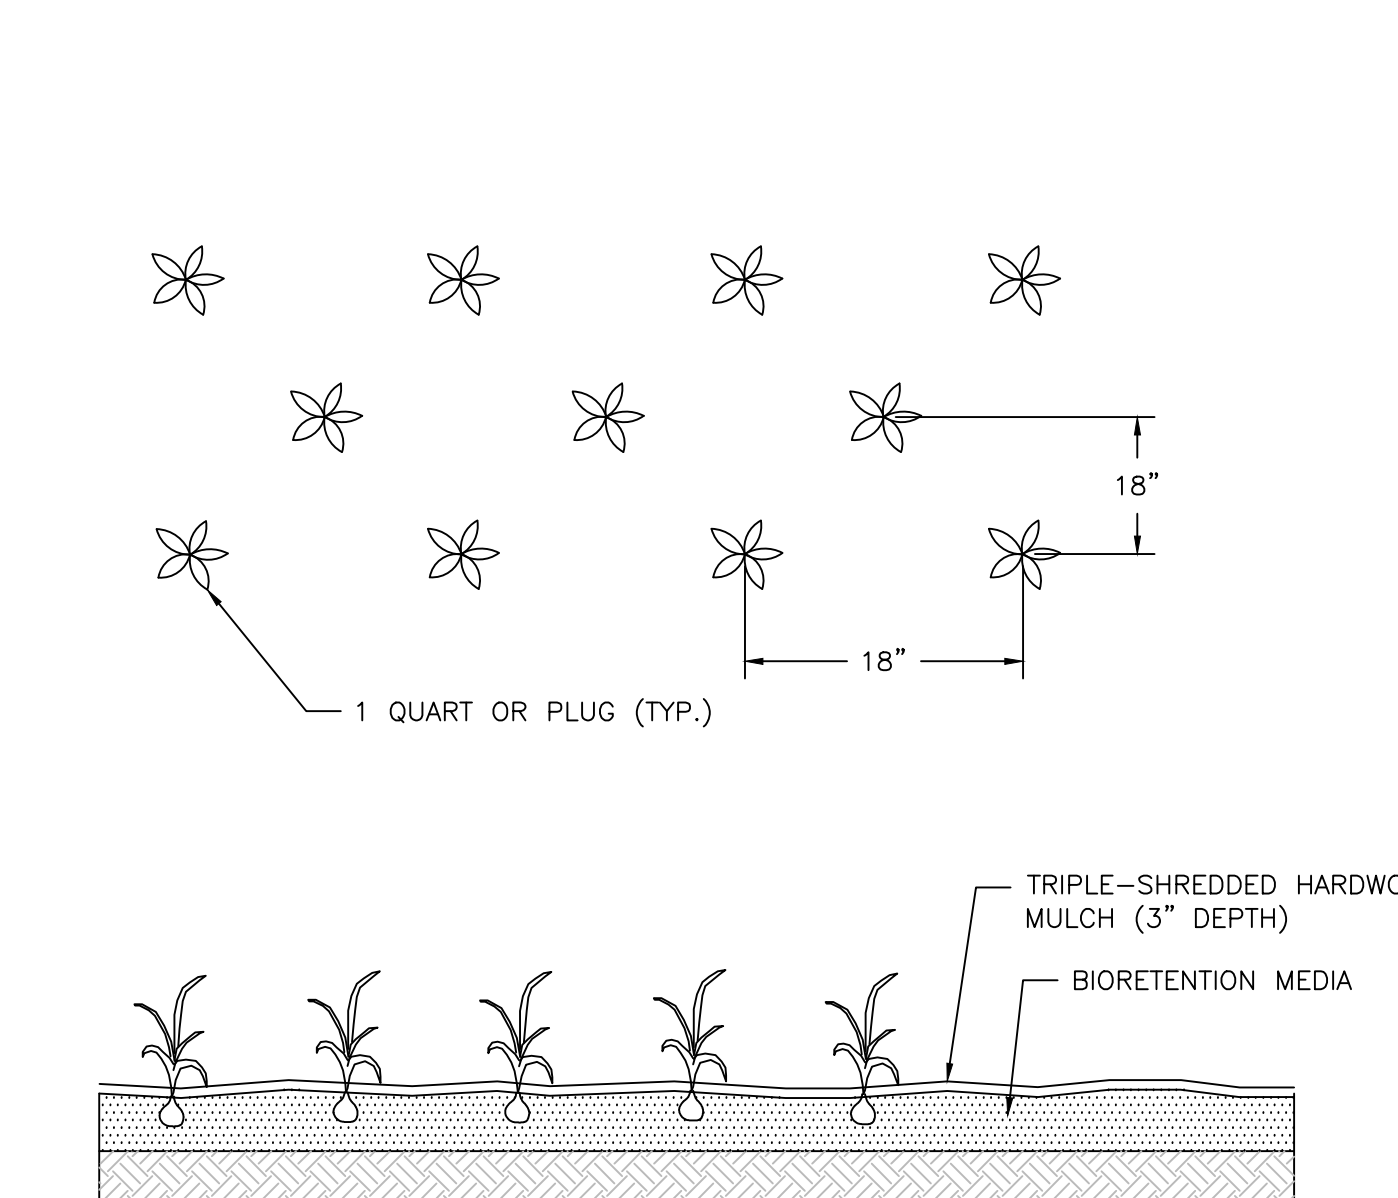

5 HERBACEOUS PLUG PLANTING DETAIL  
DT-1 N.T.S.

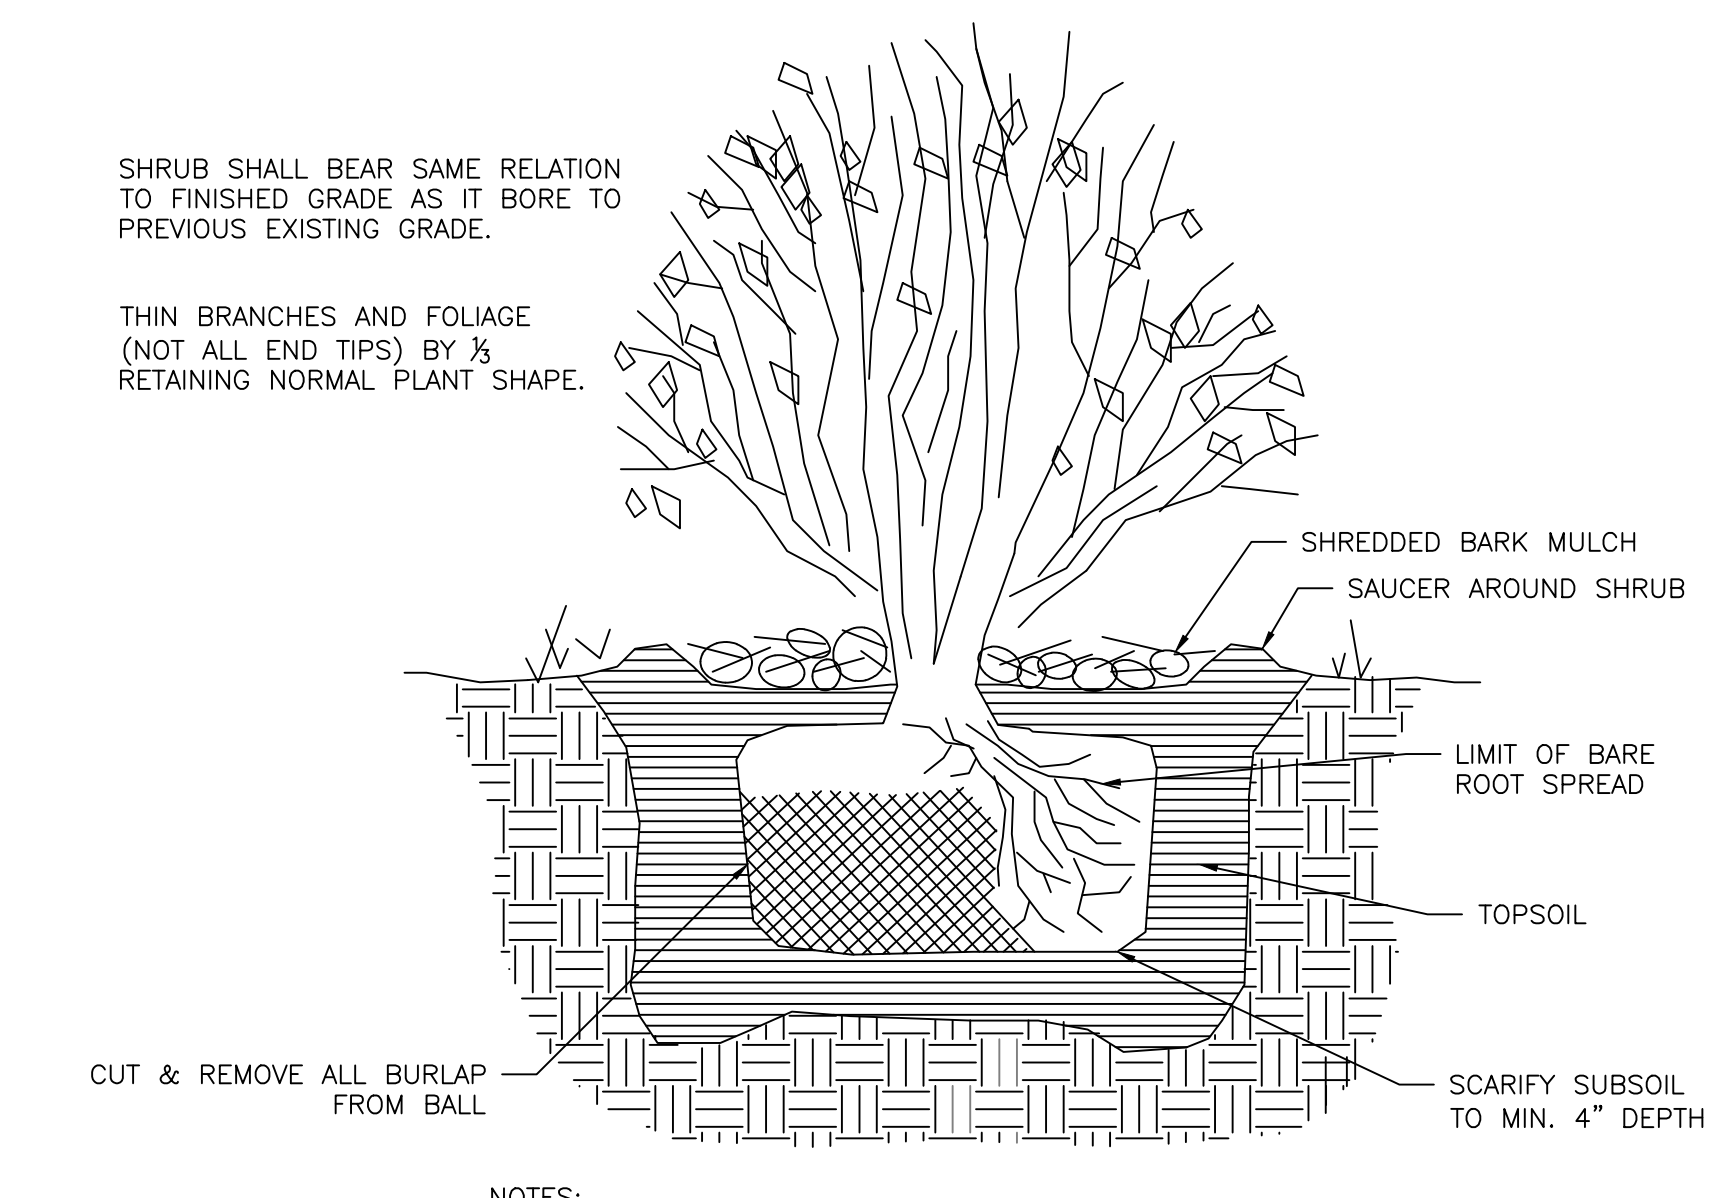

6 SHRUB PLANTING DETAIL  
DT-1 N.T.S.

CONSTRUCTION NOTES:

1. THE CONTRACTOR SHALL VERIFY ALL INFORMATION PRIOR TO EXCAVATION INCLUDING ELEVATIONS AND LOCATIONS OF EXISTING UTILITIES.
2. THE CONTRACTOR SHALL NOTIFY THE ENGINEER IMMEDIATELY IF ANY FIELD CONDITIONS DIFFER MATERIALLY FROM THOSE REPRESENTED ON THESE DRAWINGS AND THE SPECIFICATIONS OR IF, IN THE CONTRACTOR'S OPINION, SAID CONDITIONS CONFLICT WITH THE DESIGNS SHOWN HEREON.
3. THE ENGINEER SHALL INSPECT ALL PLANTING BED AREAS BEFORE MULCHING TO ENSURE THAT ADEQUATE DRAINAGE EXISTS. IF ANY AREAS TO BE MULCHED SHOW EVIDENCE OF POOR DRAINAGE, THE CONTRACTOR SHALL TAKE CORRECTIVE ACTION.
4. THE CONTRACTOR SHALL AVOID DISTURBING ALL EXISTING TREES. ANY DISTURBANCE TO TREES OR TREE ROOTS MUST BE COORDINATED WITH THE PROPERTY OWNER.
5. DIMENSIONS AND SHAPE WILL VARY. REFER TO SITE PLAN.
6. RIVER STONE PROTECTION DIMENSIONS ARE TYPICAL AND MAY VARY PER SITE. CONSULT THE ENGINEER AND SITE PLAN FOR DIMENSIONS ON A PER SITE BASIS.
7. RIVER STONE PROTECTION SHALL SLOPE TO RAIN GARDEN BASE.
8. REFER TO SITE PLAN TO DETERMINE OUTLET TYPE (ROCK-LINED OVERFLOW OR DRAINTCH RISER).
9. REFER TO SITE PLAN FOR ALL ELEVATIONS AND INVERTS.
10. THE CONTRACTOR SHALL EXCAVATE 15" LOWER THAN THE BASE ELEVATION SHOWN ON THE SITE PLANS. THE SLOPES OF THE RAIN GARDEN SHALL BE AT A 3:1 MAXIMUM.
11. THE SUBGRADE OF THE RAIN GARDEN SHALL BE LEVEL TO ENSURE PROPER DRAINAGE. CONTRACTOR SHALL OBTAIN ENGINEER APPROVAL PRIOR TO BACKFILLING WITH 12" OF BIORETENTION MEDIA.
12. THE CONTRACTOR SHALL INSTALL OVERFLOW IF SPECIFIED IN SITE PLANS PRIOR TO BACKFILLING WITH BIORETENTION MEDIA.
13. THE BIORETENTION LAYER SHALL BE LEVEL TO ENSURE PROPER DRAINAGE. CONTRACTOR SHALL OBTAIN ENGINEER APPROVAL PRIOR TO SPREADING MULCH AND PLANTING.
14. INLET AND OUTLET PROTECTION SHALL BE UNDERLAIN WITH GEOTEXTILE FABRIC.
15. INLETS AND OUTLETS SHALL NOT INHIBIT THE FLOW OF WATER FROM THE STREET. THE RIVER STONE SHALL BE PLACED BELOW THE BOTTOM OF THE PIPE.
16. THE CONTRACTOR SHALL TILL THE BERM SECTION AND BACKFILL WITH TOPSOIL.
17. ALL DISTURBED AREAS EXCLUSIVE OF RAIN GARDEN AND SLOPED BERM SHALL BE RESTORED TO ORIGINAL CONDITIONS BY CONTRACTOR.
18. THE CONTRACTOR SHALL HAVE A PRE-CONSTRUCTION MEETING WITH THE PROJECT ENGINEER PRIOR TO ANY WORK ON SITE.
19. CONTRACTOR SHALL PERFORM REQUIRED TESTING TO DETERMINE SOIL PERMEABILITY AND SEASONAL HIGH WATER TABLE ELEVATION AT THE SITE TO VERIFY INFILTRATION CAPABILITIES. TESTING SHALL BE DONE PRIOR TO EXCAVATION AND INSTALLATION OF THE PROPOSED PROJECTS. PROJECT ENGINEER SHALL BE PRESENT DURING TESTING AND SHALL BE INFORMED OF THE RESULTS.

SPECIFICATIONS:

1. MAX COVER OVER TOP OF PIPES IS 4 FT. CONTACT ADS IF OTHERWISE GREATER.
2. THE APPROVAL OF MATERIALS AND MIXING OF SAND, COMPOST, AND SOIL SHALL BE DONE UNDER THE SUPERVISION OF THE PROJECT ENGINEER/LANDSCAPE ARCHITECT. BIORETENTION MEDIA SHALL CONSIST OF 70% SAND AND 30% COMPOST MIXTURE.
3. SAND SHALL AT THE MINIMUM CONFORM TO THE SIEVE ANALYSIS FOR CONCRETE AGGREGATE SAND (ASTM C-33). USGA TEE/GREEN SIEVE GRADATION MIX IS PREFERABLE WHERE AVAILABLE.
4. UNDERLYING SOILS SHALL BE TILLED/SCARIFIED PRIOR TO SPREADING/MIXING OF BIORETENTION MEDIA.
5. ALL BIORETENTION MEDIA SHALL BE PLACED FROM THE SIDES OF THE FACILITIES, AND IN NO EVENT SHALL ANY TRACKED OR WHEELED EQUIPMENT BE PERMITTED TO CROSS THE RAIN GARDEN.
6. RAIN GARDEN SHALL BE CONSTRUCTED TO DIMENSIONS INDICATED ON THE SITE PLAN.
7. 3-5 INCH DELAWARE RIVER STONE SHALL BE USED FOR STONE CHANNEL AND INLET/OUTLET PROTECTION.
8. NON-DYED, TRIPLE-SHREDDED HARDWOOD MULCH SHALL BE USED.
9. PLANTING OF RAIN GARDEN AND SLOPED BERM SHALL BE COMPLETED AS INDICATED ON THE SITE PLAN.
10. THE CONTRACTOR SHALL PERFORM ALL WORK IN CONFORMANCE WITH THE NJDOT STANDARD SPECIFICATIONS FOR ROAD AND BRIDGE CONSTRUCTION, 2007 OR LATEST VERSION.

PLANTING AND LANDSCAPING:

- OPEN LAWN AND TURF AREAS
1. SEED ALL REMAINING PARK AREAS WITH TURF TYPE FALL FESCUE AND PERENNIAL RYEGRASS BLEND (LOFTS - SUMMER STRESS MIX II OR APPROVED EQUIVALENT). INSTALL AT A RATE OF 350 LBS. PER ACRE PER MANUFACTURERS SPECIFICATIONS.

TOPSOILING, SEEDING AND MULCHING NOTES

1. ANY UNDISTURBED AREA ON WHICH ACTIVITY HAS CEASED AND WHICH WILL REMAIN EXPOSED FOR MORE THAN 10 DAYS MUST BE SEEDED AND MULCHED IMMEDIATELY. DURING NON-GERMINATING PERIODS, MULCH MUST BE APPLIED AT THE REQUIRED RATES. DISTURBED AREAS WHICH ARE NOT AT FINISHED GRADE AND WHICH WILL BE REDISTURBED WITHIN 1 YEAR SHALL BE SEEDED AND MULCHED WITH A QUICK GROWING TEMPORARY SEEDING MIXTURE AND MULCH. DISTURBED AREAS WHICH ARE EITHER AT FINISHED GRADE OR WILL NOT BE REDISTURBED WITHIN 1 YEAR MUST BE SEEDED AND MULCHED WITH A PERMANENT SEED MIXTURE AND MULCH.
2. DIVERSIONS, CHANNELS, SEDIMENTATION BASINS, SEDIMENT TRAPS, AND STOCKPILES MUST BE SEEDED AND MULCHED IMMEDIATELY.
3. GRADED AREAS SHALL BE TEMPORARILY SEEDED AND MULCHED IMMEDIATELY FOLLOWING EARTH MOVING PROCEDURES. TEMPORARY SEED SHALL BE ANNUAL RYE GRASS APPLIED AT A RATE OF 3 LBS. PER 1000 SQ. FT.
4. AFTER SEEDING, HAY OR STRAW MULCH MUST BE APPLIED AT A RATE OF AT LEAST 3.0 TONS PER ACRE. MULCH SHALL BE ANCHORED BY EITHER CRIMPING WITH A COULTER IMPLEMENT, OR BY STAPLING BIODEGRADABLE NETTING TO THE SURFACE.
5. SITE PREPARATION TO UPLAND AREAS: APPLY 1 TON OF AGRICULTURAL-GRADE LIMESTONE PER ACRE PLUS 10-20-10 FERTILIZER AT THE RATE OF 500 LB. PER ACRE. WORK IN WHERE POSSIBLE. SEEDING OF DISTURBED UPLAND AREAS (BEYOND LIMITS OF RIPARIAN ENHANCEMENT AREA) TO BE DONE USING MIX OF FINE FESCUE AT 35 LBS/ACRE (PURE LIVE SEED) PLUS PERENNIAL RYEGRASS AT 15 LBS/ACRE (PURE LIVE SEED).
6. TOPSOIL SHALL BE A CLEAN FRIABLE LOAM WITH SUFFICIENT ORGANIC CONTENT (2.75%) TO PROMOTE PLANT VIGOR. AMENDMENTS SHALL BE ADDED AS NEEDED TO IMPROVE DEFICIENT SOILS. TOPSOIL SHALL BE RETURNED AT A LOOSE DEPTH OF FIVE INCHES TO ALLOW FOR SETTLEMENT.
7. ESTABLISH PERMANENT SEEDING AS SOON AS POSSIBLE AFTER FINAL GRADING IS COMPLETE. UNLESS OTHERWISE INDICATED, PERMANENT SEEDING SHALL BE SEED MIXTURE SPECIFIED IN TABLE.
8. SEE TABLES FOR SEED SPECIES MIXTURE AND APPLICATION RATES
9. SEED MIXES ARE AVAILABLE AT ERNST CONSERVATION SEEDS IN MEADVILLE, PA. WEBSITE: WWW.ERNSTSEED.COM OR PHONE: 1-800-873-3321.
10. NATIVE SHRUBS AND HERBACEOUS PLUGS ARE AVAILABLE AT PINELANDS NURSERY AND SUPPLY, COLUMBUS NJ. WEBSITE: WWW.PINELANDSNURSERY.COM OR PHONE 1-800-667-2729

GENERAL LANDSCAPING NOTES

1. ALL PLANT MATERIALS SHALL CONFIRM TO THE AMERICAN ASSOCIATION OF NURSERYMEN'S AMERICAN STANDARD FOR NURSERY STOCK (LATEST EDITION)
2. INSPECTION OF PLANTING BEDS - THE LANDSCAPE ARCHITECT SHALL INSPECT ALL PLANTING AREAS BEFORE ANY TOPSOILING OR PLANTING IS BEGUN TO INSURE THAT ADEQUATE DRAINAGE EXISTS. IF ANY AREAS TO BE LANDSCAPED SHOW EVIDENCE OF POOR DRAINAGE, THE LANDSCAPE ARCHITECT SHALL NOTIFY THE OWNER IMMEDIATELY FOR CORRECTIVE ACTION
3. THE LANDSCAPE ARCHITECT SHALL APPROVE ALL PLANT MATERIAL AND STAKED PLANT LOCATIONS PRIOR TO INSTALLATION. ALL HERBACEOUS PLUG PLANTINGS SHALL BE A MINIMUM 3 INCH DEPTH. PLUGS SHALL BE PLANTED 1 FOOT O.C. AS INDICATED ON PLAN.
4. ALL TREES, SHRUBS, AND GROUNDCOVER SHALL BE PLACED IN CONTINUOUS MULCHED BEDS 4" IN DEPTH. MULCH SHALL BE TRIPLE SHREDDED HARDWOOD.
5. ALL TREES, SHRUBS, AND GROUNDCOVER SHALL BE AS SPECIFIED AND SHALL BE INSTALLED IN ACCORDANCE WITH THE DETAILS AND COMMENTS NOTED ON THE DRAWINGS.
6. TOPSOIL SHALL BE PROVIDED BY THE LANDSCAPE CONTRACTOR FOR PLANTING ACCORDING TO THE PLANS AND DETAILS
7. PREPARED TOPSOIL FOR BACKFILLING AROUND TREE BALLS SHALL BE A MIXTURE OF VOLUME OF THE FOLLOWING MATERIALS IN QUANTITIES SPECIFIED: 1/3 COMPOST, 2/3 TOPSOIL
8. ALL HERBACEOUS PLUG PLANTINGS SHALL BE MINIMUM 3 INCH DEPTH. PLUGS SHALL BE PLANTED 1 FOOT O.C. AS INDICATED ON PLAN.

QUANTITY/COST ESTIMATES		
Rain Garden	Quantity	Cost
Excavation (CY)	46	\$ 1,840.00
Bioretention Soil	Concrete Sand (CY)	18 \$ 875.00
	Compost (CY)	8 \$ 225.00
Mulch (CY)	10	\$ 300.00
3-5" River Stone (Tons)	1.0	\$ 50.00
Landscape Fabric (SF)	40	\$ 10.00
Plants	Perennials	250 \$ 750.00
	Shrubs	7 \$ 84.00
HDPE Pipe and Fittings (Feet)	30	\$ 150.00
<b>Total Cost</b>		<b>\$ 4,284.00</b>

PLANTING SCHEDULE					
PLANT SPECIES				QUANTITY	SIZE
TYPE	KEY	BOTANICAL NAME	COMMON NAME		
RAIN GARDEN					
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	LC	<i>Lobelia cardinalis</i>	CARDINAL FLOWER	40	1 QUART
	SS	<i>Schizachyrium scoparium</i>	LITTLE BLUESTEM	40	1 QUART
SHRUBS	MP	<i>Myrica pensylvanica</i>	BAYBERRY	3	#2 CONT.
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POLLINATOR GARDEN					
PERRINALS	AS	<i>Asclepias syriaca</i>	COMMON MILKWEED	15	1 QUART
	BA	<i>Baptisia australis</i>	BLUE WILD INDIGO	15	1 QUART
	EP	<i>Eutrochium purpureum</i>	JOE PYE WEED	20	1 QUART
	RH	<i>Rudbeckia hirta</i>	BLACK-EYED SUSAN	15	1 QUART
	SN	<i>Symphoricarpon novae-angliae</i>	NEW ENGLAND ASTER	20	1 QUART

STORMWATER CALCULATIONS								
GREEN INFRASTRUCTURE PRACTICE	SIZE (SF)	STORAGE VOLUME (CF)	TOTAL DRAINAGE AREA (SF)	STORM TYPE	MANAGED DRAINAGE AREA (SF)	PEAK RUNOFF REDUCTION (CFS)	RUNOFF VOLUME MANAGED (GAL.)	ANNUAL RUNOFF VOLUME MANAGED (GAL./YR)
RAIN GARDEN	845	650	4,215	2-YR	4,125	0.24	7,974	68,536

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RAIN GARDEN DETAILS

RUTGERS  
New Jersey Agricultural  
Experiment Station

SHEET NAME  
DT-1





1  
DT-2

RENDERING  
N.T.S.

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*Christopher C. Obropta*

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